
# This electronic collection of documents is provided for the convenience of the user and is Not a Certified Document –


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shall not be considered a certified document.

DESCRIPTION

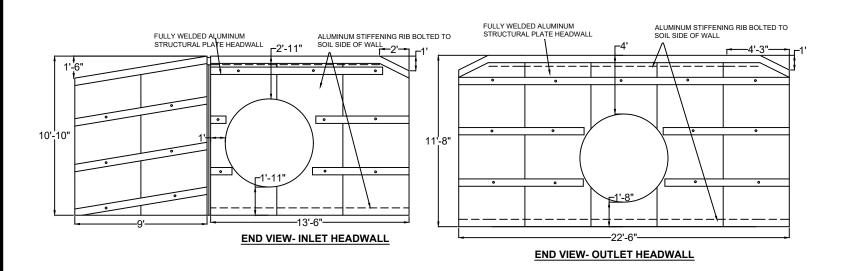



## NCDOT ALEXANDER CO 168 MILSTEAD ORCHARD LANE TAYLORSVILLE, NC

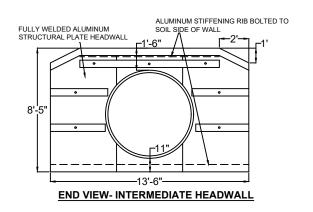POMONA PIPE PRODUCTS 4611 DUNDAS DR. GREENSBORO, NC 27407 336-292-8060



SHEET


DATE: JAN 20, 2023 REV NOT TO SCALE


#### DESCRIPTION ALEXANDER 51 LF OF 72" DIA, 10 GAGE, 3"X1" ALUMINUM PIPE WITH FLANGED & GASKETED JOINTS **INTERMEDIATE PROPOSED ELEVATIONS: HEADWALL** 168 MILSTEAD TAYLORSVILL TOP € ROAD= 1202.91 TOP OF HW IN= 1201.16 TOP OF HW OUT= 1201.10 **TOP OF PIPE IN= 1198.27** TOP OF PIPE OUT= 1197.16 **FLOW** INV STREAM IN= 1193.28 INV PIPE IN= 1192.27 INV STREAM OUT= 1192.16 **INV PIPE OUT= 1191.16** -30' -51'-**PLAN VIEW** POMONA PIPE PRODUCTS 4611 DUNDAS DR GREENSBORO, NC 27407 336-292-8060 POMONA PIPE PRODUCTS POMONAPIPEPRODUCTS.COM DATE: JAN 20, 2023 SHEET REV NOT TO SCALE


REMARKS


BEVEL CUT ON TOP


PIPE WELDED TO PLATE

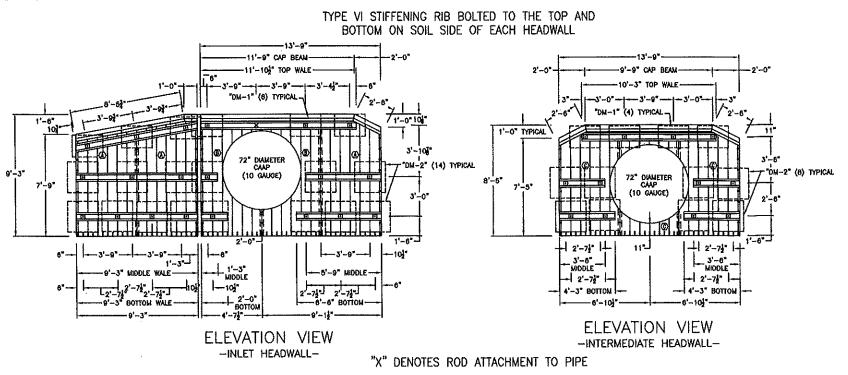

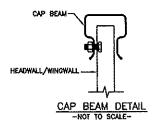


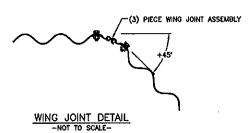

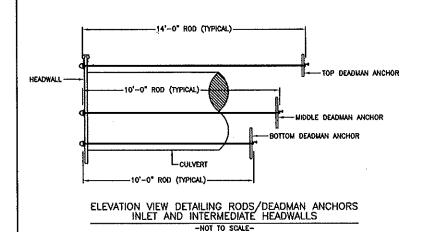


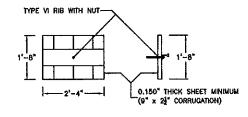


TOP SINGLE ROD ANCHOR DETAIL (DM-1)

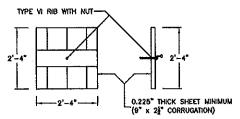

MIDDLE & BOTTOM SINGLE ROD ANCHOR DETAIL (DM-2)

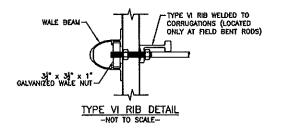

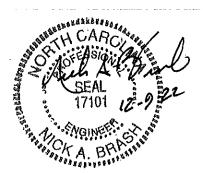

INLET AND INTERMEDIATE HEADWALL NOTES:

1.) The Depth Of Bury Is Defined As The Amount Of Soil Cover Above The Top Of The Highest Point Of The Deadman.

2.)—The Minimum—Burial—Depth—For The Top—Deadman—Anchor—Is—2'—0" (Inlet—& Intermediate)—From Top—Of—Road.
3.) The Minimum Burial Depth For The Middle Deadman Anchor Is 4'—5" (Inlet & Intermediate) From Top Of Road.
4.) The Minimum Burial Depth For The Bottom Deadman Anchor Is 7'—6" (Inlet & Intermediate) From Top Of Road.

5.) All Backfill Material In The Structural Zone Is To Be #57 Stone — Separation Fabric May Be Required To Prevent Soil Migration.

Comprehensive Construction Services, Inc. 1326 Grandin Road SW Roanoke, VA 24015 (540) 344-3003 FAX(540) 344-3337 Firm License No. C-2875

| ^                                 | I LAI   |          | ۷. | 12   | 3.20     | .200    | THE HELL         | DED TO PURIL       |
|-----------------------------------|---------|----------|----|--|----------|---------|------------------|--------------------|
| Х                                 | FLAT    | (C)      | 3  | 10   | 8.42'    | .150"   | PIPE WELD        | DED TO PLATE       |
| X                                 | FLAT    | 0        | 2  | 15   | 11.67    | .200*   | BEVEL C          | CUT ON TOP         |
| Χ                                 | FLAT    | (E)      | 2  | 15   | 11.67    | .200"   | PIPE WELD        | DED TO PLATE       |
|                                   |         | DM1      | 15 | 2  | 1.67'    | .225"   | DEADMAN          | WITH TYPE VI       |
|                                   |         | DM2      | 36 | 3  | 2.33'    | .225"   | DEADMAN          | WITH TYPE VI       |
|                                   | ·       |          | 1  |  | 8.48     |         | ALUMINUM CA      | AP BEAMS           |
|                                   |         |          | 1  |  | 11.75    |         | ALUMINUM C       | AP BEAMS           |
|                                   |         |          | 1  |  | 1.00'    |         | ALUMINUM C       | AP BEAMS           |
|                                   |         |          | 1  |  | 9.75'    |         | ALUMINUM C       | AP BEAMS           |
|                                   |         |          | 1  |  | 14.25    |         | ALUMINUM CA      | AP BEAMS           |
|                                   |         |          | 5  |  | 2.50'    |         | ALUMINUM C       | AP BEAMS           |
|                                   |         |          | 1  |  | 11.87    |         | ALUMINUM WA      | LE BEAMS           |
|                                   |         |          | 1  |  | 9.39     |         | ALUMINUM WA      | LE BEAMS           |
|                                   |         |          | 2  |  | 9.25     |         | ALUMINUM WA      | LE BEAMS           |
| ·                                 |         |          | 1  |  | 1.25'    |         | ALUMINUM WA      | ILE BEAMS          |
|                                   |         |          | 1  |  | 2.00'    |         | ALUMINUM WA      | LE BEAMS           |
|                                   |         |          | 1  |  | 5.25     |         | ALUMINUM WA      | ILE BEAMS          |
|                                   |         |          | 1  |  | 6.50     |         | ALUMINUM WA      | ILE BEAMS          |
|                                   |         |          | i  |  | 10.25    |         | ALUMINUM WA      | LE BEAMS           |
|                                   |         | 1        | 2  |  | 3,50     |         | ALUMINUM WA      | LE BEAMS           |
|                                   |         |          | 2  |  | 4.25'    |         | ALUMINUM WA      | LE BEAMS           |
|                                   |         |          | 1  |  | 16.25    |         | ALUMINUM WA      | LE BEAMS           |
|                                   |         |          | 2  |  | 6.12'    |         | ALUMINUM WA      | LE BEAMS           |
|                                   |         | <b>1</b> | 2  |  | 6.87     |         | ALUMINUM WA      |                    |
|                                   |         |          | 2  |  | 7.25     |         | ALUMINUM WA      | ILE BEAMS          |
|                                   |         |          | 56 |  |          |         | WALE N           |                    |
|                                   |         |          | 5  | 3/4"   | DIA. X 1 | 8'-0" L |                  | DEADMAN ANCHORS    |
|                                   |         |          | 6  |  |          |         |                  | DEADMAN ANCHORS    |
|                                   |         |          | 10 |  |          |         |                  | DEADMAN ANCHORS    |
|                                   |         | 1        | 4  |  |          |         |                  | DEADMAN ANCHORS    |
| ,                                 |         | <b>†</b> | 26 |  |          |         |                  | DEADMAN ANCHORS    |
|                                   |         | †        | 5  | 7.   |          |         | T RODS ATTACHE   |                    |
|                                   |         | 1        | 1  | <del> </del>                                 |          |         | E WING ASSEMI    |                    |
| SHIPMENT SI                       | UMMARY: | .l       | •  | <u>)                                    </u> |          | V //E   | 2 11110 11002311 |                    |
| SPECIFICATIONS: AASHTO M219 GAGE: |         |          |    |  |          |         |                  |                    |
| ADDOMINATE CHIDDING MICHIE.       |         |          |    |  | TAD.     |         |                  |                    |
| CUSTOMER:                         |         |          |    |  | IUP:     |         |                  |                    |
|                                   |         |          |    |  |          |         |                  | SIDES:             |
|                                   |         |          |    |  |          |         |                  | CORNER:<br>BOTTOM: |
|                                   |         |          |    |  |          |         |                  | DUTTUM:            |

ASSEMBLY REQUIREMENTS-HEADWALLS & WINGWALL

(A) 3 | 12 | 9.25' | .200"

(B) 2 12 9.25' .200"

HEAT NO.

PROJECT:

DRAWN BY: JEC

DATE: 12/08/2022

CHECKED BY:

APPROVED BY:

SCALE: NTS

NCDOT - IREDELL COUNTY

NO. DATE

1

2

HEADWALLS (0.200" & 0.150" THICKNESS) DIAMETER, 3" x 1" CORRUGATION, 10 GAUGE

BY

LANE METAL PRODUCTS DIVISION

of LANE ENTERPRISES, INC.

CAMP HILL, PA


REVISIONS:

NOTES


54-DM-12057694A

LANE PROJECT NUMBER:

RADIUS

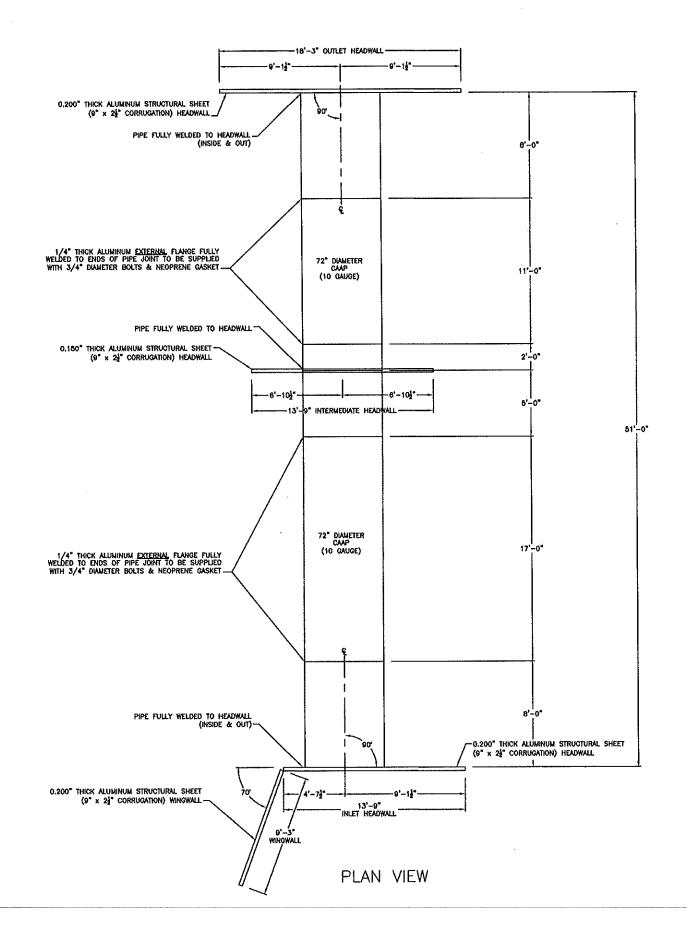

#### TYPE VI STIFFENING RIB BOLTED TO THE TOP AND BOTTOM ON SOIL SIDE OF EACH HEADWALL

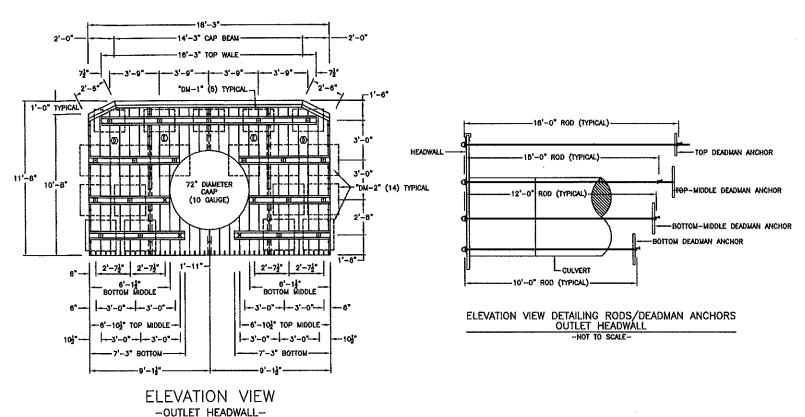

"X" DENOTES ROD ATTACHMENT TO PIPE

#### **OUTLET HEADWALL NOTES:**

- 1.) The Depth Of Bury is Defined As The Amount Of Soil Cover Above The Top Of The Highest Point Of The Deadman.
- 2.) The Minimum Burial Depth For The Top Deadman Anchor is 2'-0" (Outlet) From Top Of Road.
- 3.) The Minimum Burial Depth For The Top Middle Deadman Anchor Is 4'-5" (Outlet) From Top Of Road.
- 4.) The Minimum Burial Depth For The Bottom Middle Deadman Anchor is 7'-6" (Outlet) From Top Of Road.
- 5.) The Minimum Burial Depth For The Bottom Deadman Anchor Is 10'-7" (Outlet) From Top Of Road.
- 6.) All Backfill Material in The Structural Zone is To Be #57 Stone Separation Fabric May Be Required To Prevent Soil Migration.



Comprehensive Construction Services, Inc. 1326 Grandin Road SW Roanoke, VA 24015 (540) 344-3003 FAX(540) 344-3337 Incorporated ( Firm License No. C-2875

| SHIPMENT SUMMARY:   |             |         |
|---------------------|-------------|---------|
| SPECIFICATIONS:     | AASHTO M219 | GAGE:   |
| APPROXIMATE SHIPPIN | G WEIGHT:   | TOP:    |
| CUSTOMER:           |             | 101.    |
|                     |             | SIDES:  |
|                     |             | CORNER: |
|                     |             | BOTTOM: |


NCDOT - IREDELL COUNTY HEADWALLS (0.200" & 0.150" THICKNESS) 72" DIAMETER, 3" x 1" CORRUGATION, 10 GAUGE

| DRAWN BY: JEC    | REVISIONS: |      |    |        |  |
|------------------|------------|------|----|--------|--|
| CHECKED BY:      | NO.        | DATE | BY | NOTES  |  |
| APPROVED BY:     | 1          |      |    |        |  |
| DATE: 12/08/2022 | 2          |      |    |        |  |
| SCALE: NTS       | 1          |      |    | IFB #: |  |

PROJECT:

LANE METAL PRODUCTS DIVISION 54-DM-12057694A of LANE ENTERPRISES, INC. CAMP HILL, PA

LANE PROJECT NUMBER:

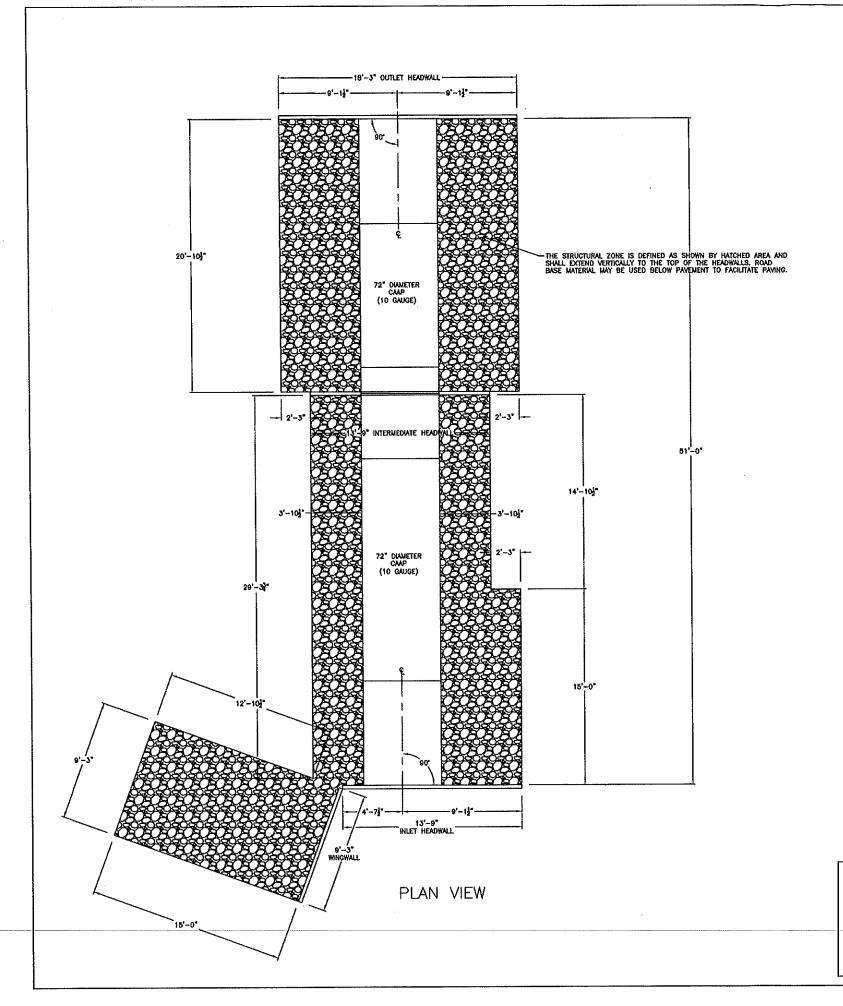

Aluminum Structural Plate Headwall Installation Instructions:

- 1.) Aluminum structural plate headwalls shall conform to the latest requirements of AASHTO M219 or ASTM B746 with a minimum thickness of 0.200" (Inlet/Outlet) and 0.150" (Intermediate).
- 2.) Headwalls may incorporate the full variety of shapes and sizes available in corrugated metal pipe and structural plate culverts (arch pipe, arch, box culvert, et al). Additionally, headwalls may be equipped with wingwalls of the same design and material. However, it shall be incumbent upon the project engineer to ensure constructability and structural adequacy through the implementation of submittal requirements (shop drawings, calculations, etc).
- 3.) It shall be the responsibility of the installation crew to implement sound installation practices consistent with AASHTO LRFD Bridge Construction Practices. As necessary and at the discretion of the project engineer, the headwall manufacturer or other expertise may be enacted to supervise construction when a bid item for such activity has been included in the contract documents or project specifications.
- 4.) The site shall be excavated per design plans and OSHA requirements. Bedding shall be prepared per Design Engineers specifications to achieve bearing capacity and establish line & grade. The headwall shall be properly placed at the design elevation by ensuring the stub is placed at grade for the culvert crossing.
- 5.) Backfill placement and compaction shall be consistent with Section 26 of the AÁSHTO LRFD Bridge Construction Specifications. All backfill in the structural zone shall be #57 washed stone or other as approved by the engineer of record. Deadman anchors and rods shall be attached to the headwall & wings at the predetermined design elevations per design drawings.
- 6.) The headwall shall be properly shored through the backfilling process. In géneral, the wall should be braced at the wale line located above the fill line until the corresponding anchor is completely embedded. The wall shall also be braced at the top anchor location until completely backfilled.
- 7.) All steel components (nuts, bolts, tie back rods) shall have a hot-dipped galvanized coating.
- 8.) As a matter of expedience and to the extent practical, the headwall-culvert system may be completely or partially assembled and lifted as a unit to facilitate placement of the unit in a prepared excavation complete with bedding to grade.



Comprehensive Construction Services, Inc. 1326 Grandin Road SW Roanoke, VA 24015


(540) 344-3003 FAX(540) 344-3337 Firm License No. C-2875

| SHIPMENT SUMMARY:   |             |                   |
|---------------------|-------------|-------------------|
| SPECIFICATIONS:     | AASHTO M219 | GAGE:             |
| APPROXIMATE SHIPPIN | G WEIGHT:   | TOP:              |
| CUSTOMER:           |             |                   |
|                     |             | SIDES:<br>CORNER: |
|                     |             | BOTTOM:           |
|                     |             |                   |
| PROJECT:            |             |                   |

NCDOT - IREDELL COUNTY HEADWALLS (0.200" & 0.150" THICKNESS) 72" DIAMETER, 3" x 1" CORRUGATION, 10 GAUGE


| DRAWN DI: JEC    | IZEAIOINIAS: |         |                         |                      |                 |  |  |
|------------------|--------------|---------|-------------------------|----------------------|-----------------|--|--|
| CHECKED BY:      | NO.          | DATE    | BY                      | NOTES                |                 |  |  |
| APPROVED BY:     | 1            |         |                         |                      |                 |  |  |
| DATE: 12/08/2022 | 2            |         |                         |                      |                 |  |  |
| SCALE: NTS       |              | - METAL | DDADIII                 | OTO DIVIDIONI        | JFB #:          |  |  |
|                  | LANI         |         |                         |                      | 54-DM-12057694A |  |  |
|                  |              | of LAN  | E ENTERPR<br>CAMP HILL. | LANE PROJECT NUMBER: |                 |  |  |
|                  |              |         |                         |                      |                 |  |  |

CAMP HILL, PA

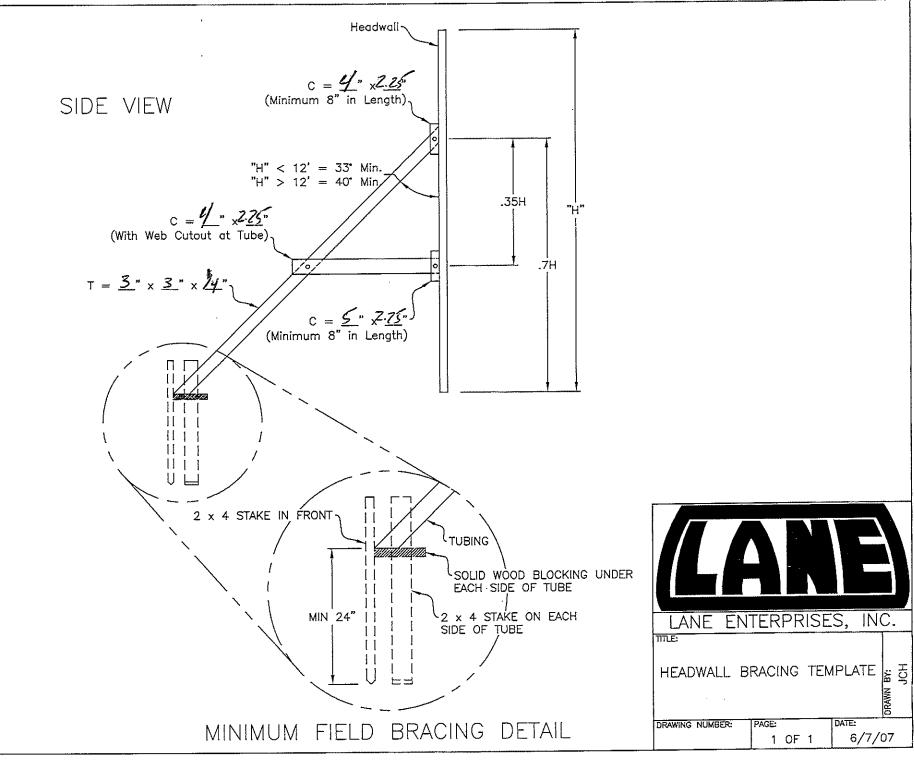


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### 

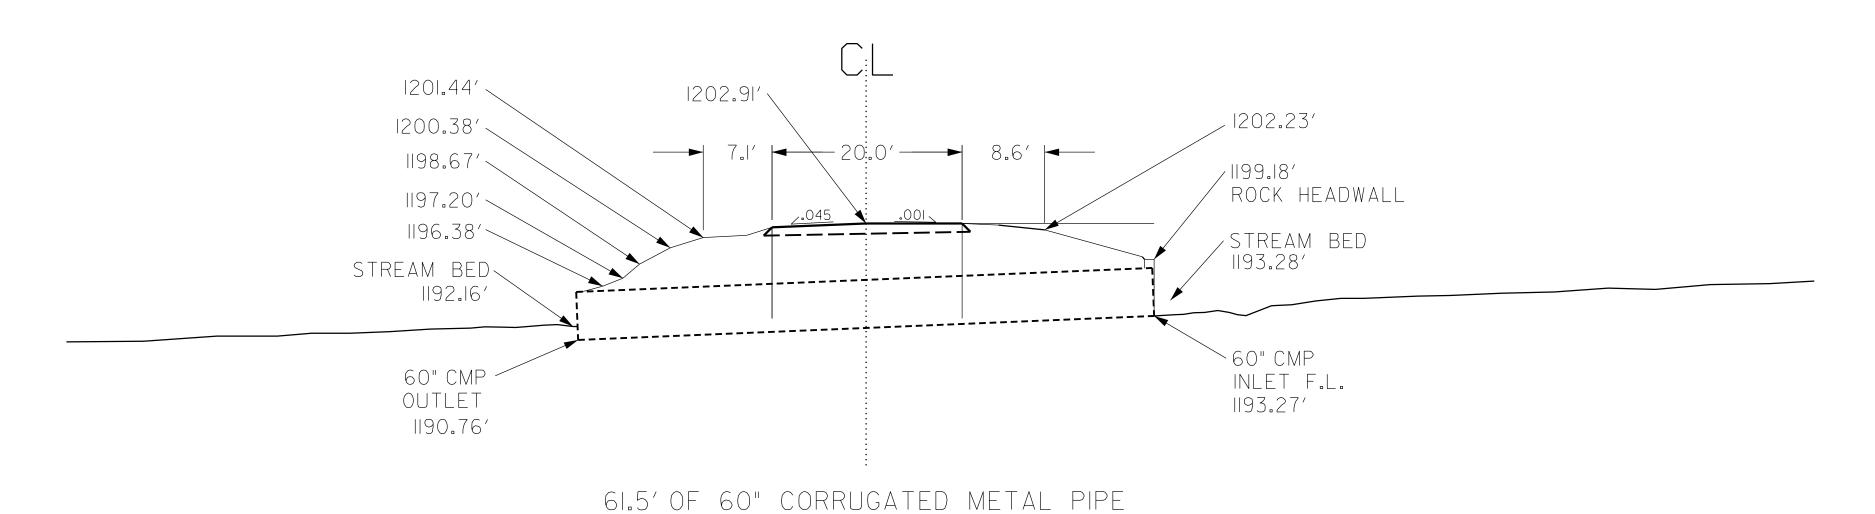

### EXISTING ROADWAY TYPICAL SECTION

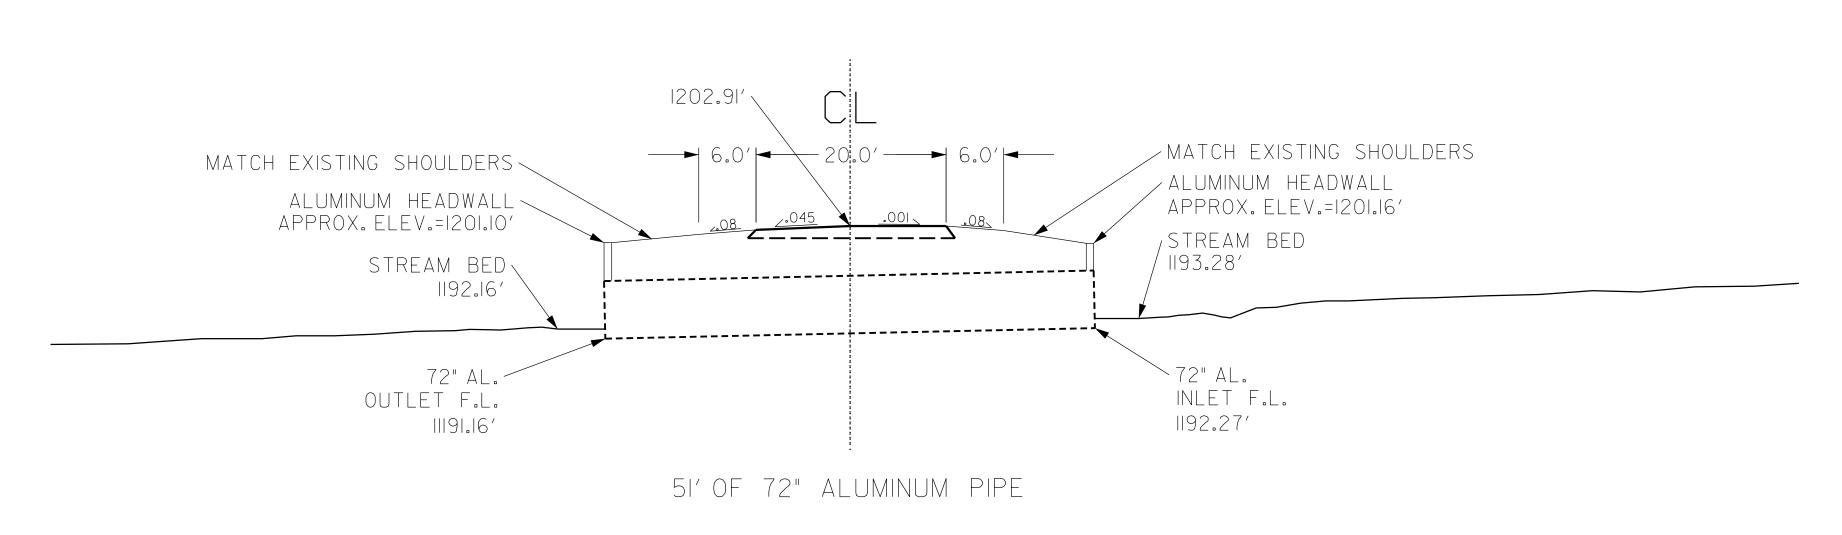


PROPOSED ROADWAY TYPICAL SECTION


PIPE REPLACEMENT

MILSTEAD ORCHARD LN SR 1350

ALEXANDER COUNTY NC

\$\$\$\$\$\$\$YSTIME\$\$\$\$\$ \$\$\$\$\$\$\$\$\$\$\$\$\$\$DGN\$\$\$\$\$\$\$\$\$\$\$\$\$ \$\$\$\$USFRNAMF\$\$\$\$

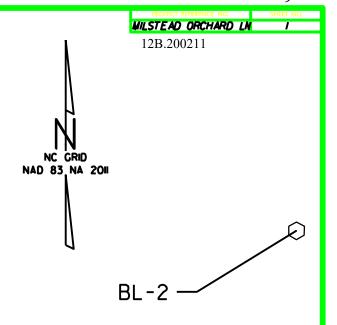


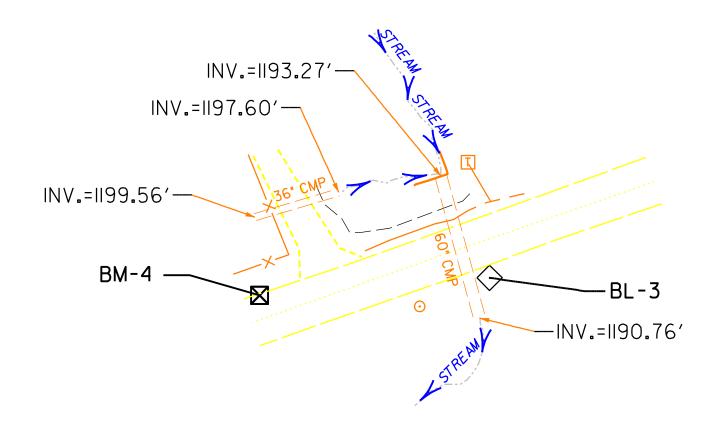


BL


4 ELEVATION - 1205.90 N 803225 E 1328353 MAGNAIL @ EDGE OF PAVEMENT

|   | POINT | DESC. | NORTH       | EAST         | ELEVATION |
|---|-------|-------|-------------|--------------|-----------|
| 1 |       |       | 803083.5770 | 1328099.9110 | 1219.76   |
| 2 |       |       | 803398.4890 | 1328762.4440 | 1197.10   |
| 3 |       |       | 803232.0980 | 1328448.5140 | 1201.25   |

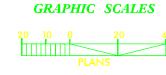



VICINITY MAP (NTS) ALEXANDER COUNTY

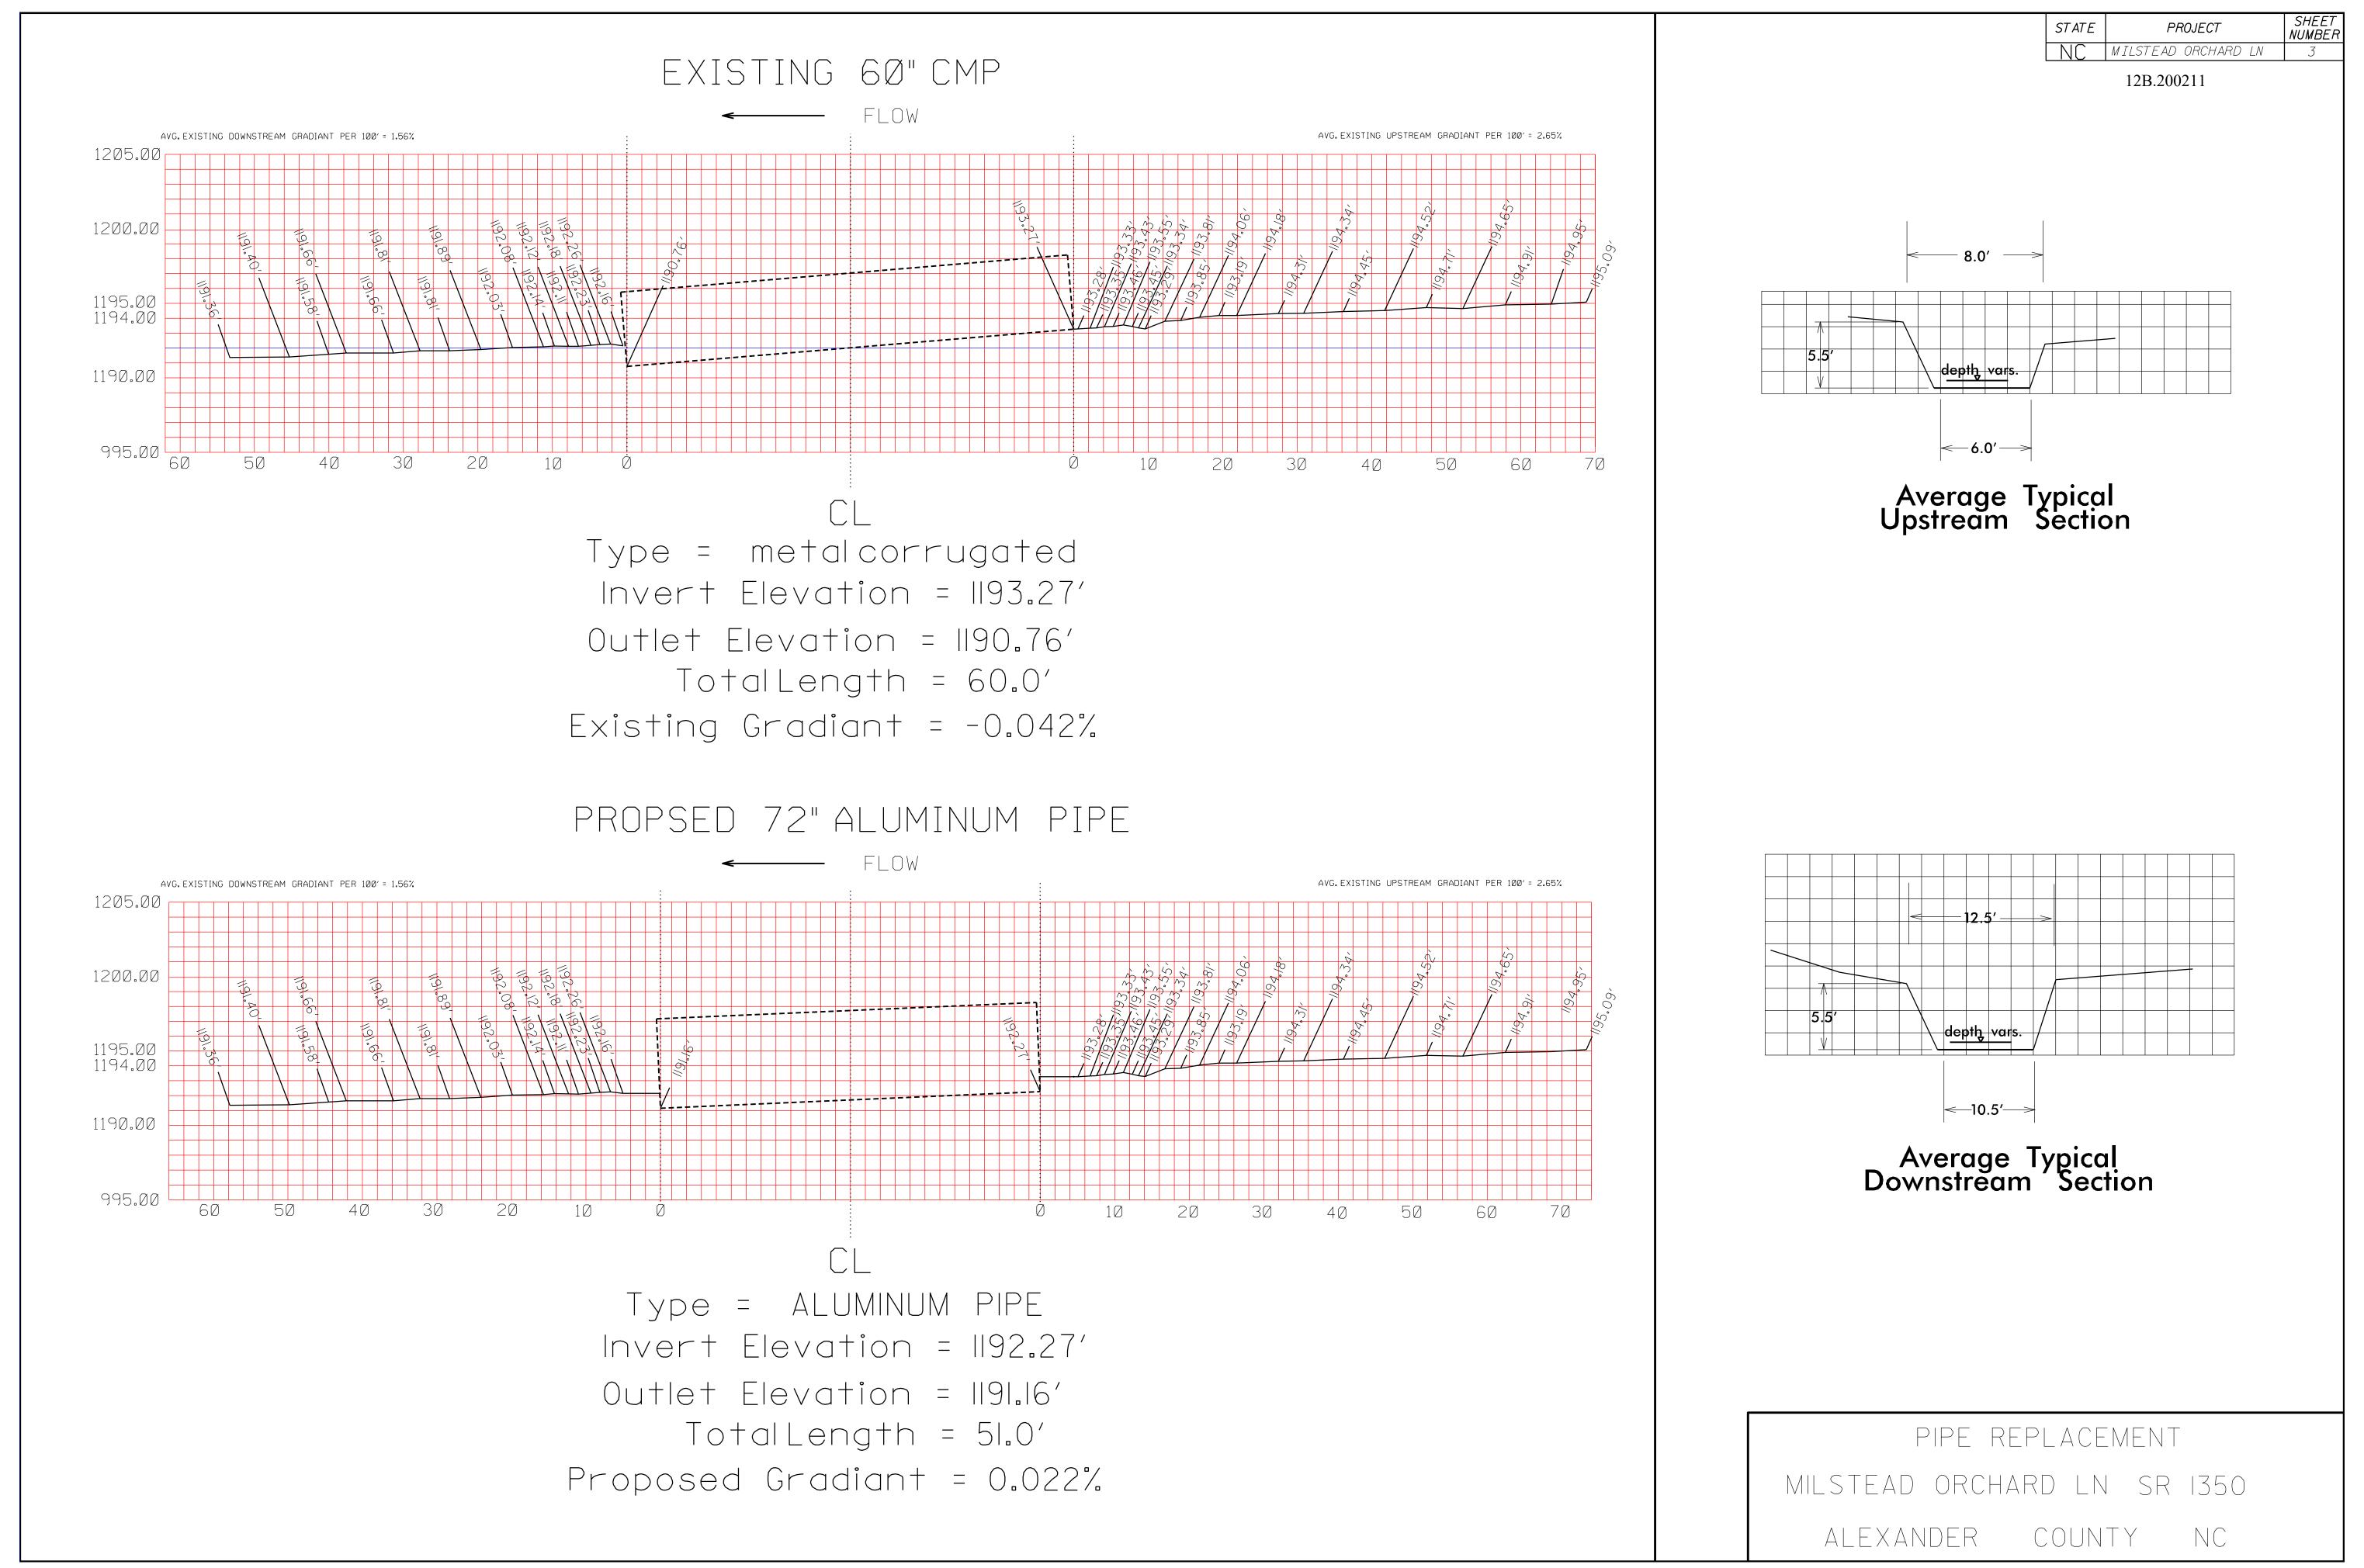

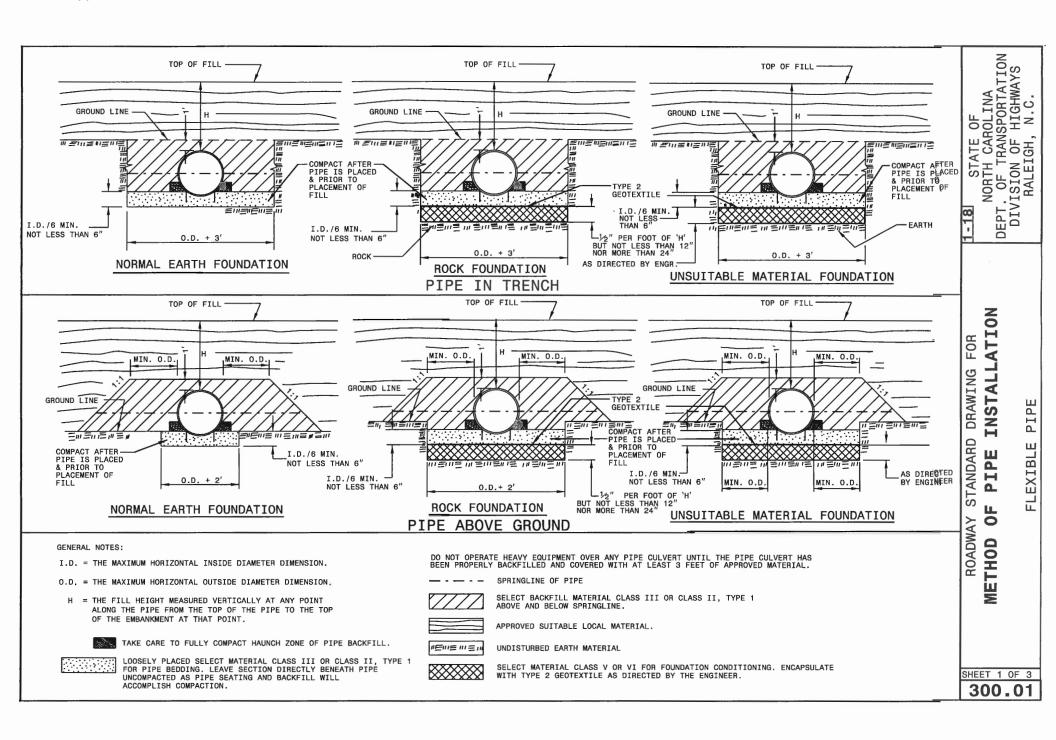

12B.200211

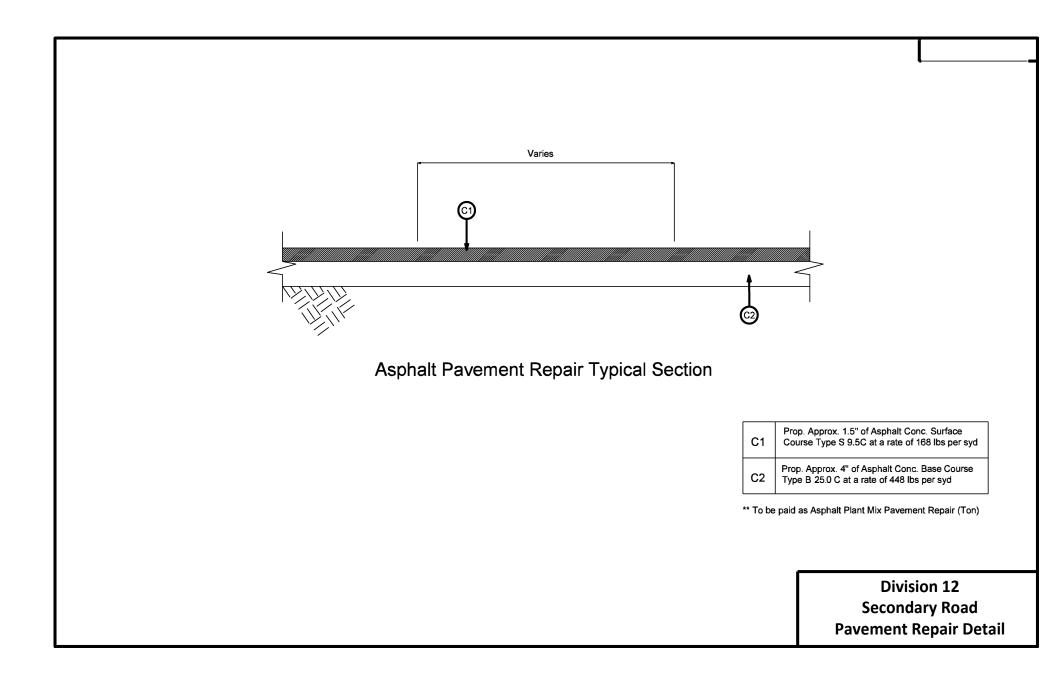

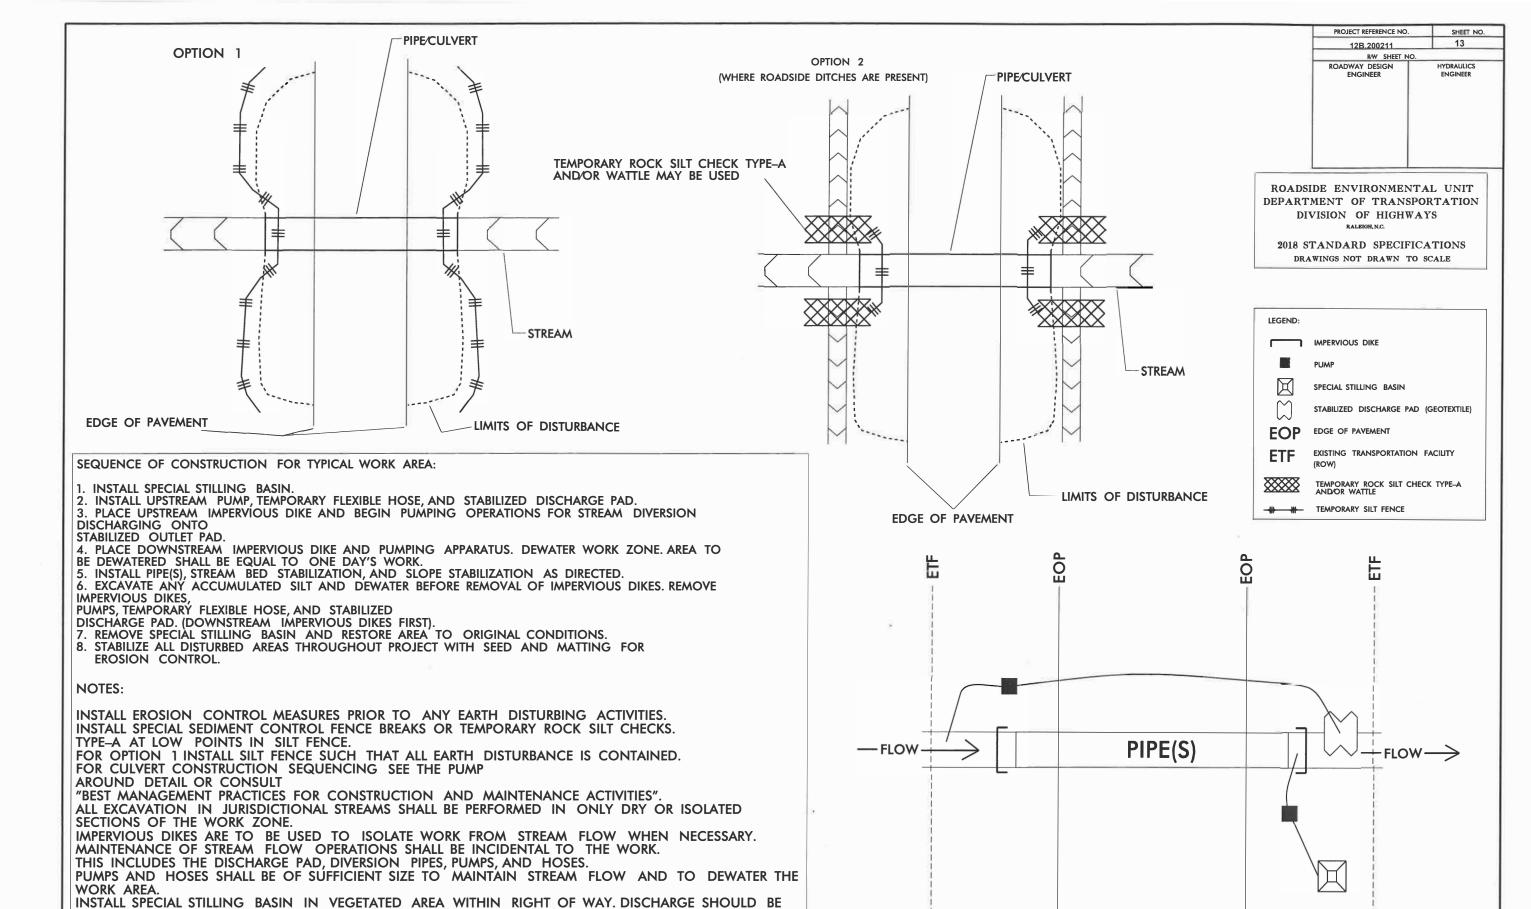

DIRECTED THROUGH VEGETATED BUFFER AWAY FROM WORK SITE.

FOR CONSTRUCTION AND MAINTENANCE ACTIVITIES MANUAL.

RECLAMATION PLAN.

INSTALL SILT FENCE AS DIRECTED TO CONTAIN DISTURBED AREAS AND/OR EXCAVATED STOCKPILES. BORROW MATERIAL FROM OR DISPOSAL OF MATERIAL TO ANY UNPERMITTED SITE WILL REQUIRE A

INSTALL PIPE(S) IN JURISDICTIONAL AREAS IN ACCORDANCE WITH NCDOT BEST MANAGEMENT PRACTICES

PUMP-AROUND OPERATION FOR PIPE REPLACEMENT IN JURISDICTIONAL STREAMS EROSION CONTROL DETAIL